

# FLOOR PLAN





LIVING AREA = 84.1 GARAGE AREA = 23.2 ALFRESCO = 16.2PATIO = 1.2

#### TOTAL AREA = 124.7 m2



\*NOTES\* NO CUT OR FILL REQUIRED NO TREES TO BE REMOVED

#### EXTERNAL COLOURS & MATERIAL FINISHES \* ROOF-COLORBOND- GREY \* GUTTER-COLORBOND - MONUMENT \* FASCIA-COLORBOND- GREY MEDIUM FACE BRICK \* BRICKS-ALUMINIUM- GREY \* WINDOWS-\* FRONT DOOR-TIMBER- CLEAR STAINED \* GARAGE DOOR-COLORBOND- GREY

ALL CARE IS TAKEN WITH DIMENSIONS BUT NO RESPONSIBILITY ACCEPTED FOR DISCREPANCIES. MEASUREMENTS TAKE PRECEDENCE OVER SCALE. IT IS THE TENDER'S RESPONSIBILITY TO CHECK ALL ON SITE HEIGHTS, LEVELS & MEASUREMENTS. EVERY PART OF THE BUILDING & ASSOCIATE COMPONENTS MUST BE CONSTRUCTED IN AN APPROPRIATE MANNER TO ACHIEVE THE REQUIREMENTS OF THE HOUSING PROVISIONS USING MATERIALS THAT ARE FIT FOR THE PURPOSE FOR WHICH THEY ARE INTENDED. THE BUILDING & ANY ASSOCIATED SITE WORK IS TO BE CONSTRUCTED IN A WAY THAT PROTECTS SURROUNDING OCCUPANTS & PROPERTY FROM ADVERSE EFFECTS OF REDIRECTED SURFACE WATER. THE BUILDING IS TO BE CONSTRUCTED TO PROVIDE RESISTANCE TO MOISTURE FROM OUTSIDE & MOISTURE RISING FROM THE GROUND ANY HEATING APPLIANCE & ASSOCIATED COMPONENT MUST BE INSTALLED BY A LICENSED PERSON & COMPLY TO BCA PART 3.10.7.
ALL CONSTRUCTION METHODS & MATERIALS MUST COMPLY TO ANY & ALL BASIX, NATHERS OR ALTERNATIVE THERMAL/ENERGY ASSESSMENTS & IT IS THE ASSESSMENTS & IT IS THE BUILDERS RESPONSIBILITY TO ENSURE ALL TRADES RECEIVE COPIES OF SUCH ASSESSMENTS. ALL EARTHWORKS ARE TO BE UNDERTAKEN STRICTLY TO COMPLY TO NCC PART 3.1.

A TERMITE BARRIER MUST BE INSTALLED STRICTLY TO COMPLY TO NCC 3.1.
ALL CONCRETE FOOTINGS & SLABS
ARE TO BE CONSTRUCTED STRICTLY TO BCA 3.2. & ENGINEERS SPECIFICATIONS.

ALL STORM WATER & SURFACE

DRAINAGE IS TO BE UNDERTAKEN STRICTLY TO COMPLY TO NCC 3.1.

ALL MASONRY & ASSOCIATED COMPONENTS IS TO BE CONSTRUCTED STRICTLY TO COMPLY TO NCC 3.3. SUB-FLOOR VENTILATION WHERE

REQUIRED MUST COMPLY TO NCC ALL TIMBER FRAMING , WIND BRACING

& ASSOCIATED COMPONENTS MUST COMPLY TO AS1684-N1/N2-2010 OR ENGINEERS DESIGN. ROOF CLADDING & ASSOCIATED COMPONENTS MUST BE INSTALLED STRICTLY AS TO COMPLY TO NCC 3.5.1. OR 3.5.2.

GUTTERS, DOWN PIPES &
ASSOCIATED COMPONENTS MUST BE
INSTALLED STRICTLY AS TO COMPLY TO NCC 3.5.3.
ALL WALL CLADDING & ASSOCIATED COMPONENTS MUST COMPLY TO NCC 3.5.4 OR 3.5.5.

ALL GLAZING IS TO COMPLY TO NCC 3.6. & ANY REQUIREMENTS UNDER BASIX, NATHERS OR ALTERNATIVE THERMAL/ENERGY ASSESSMENTS. DIRECT WIRED SMOKE DETECTORS
MUST COMPLY WITH AS3786 & BE INSTALLED AS TO COMPLY TO NCC

ALL REQUIRED AREAS ARE TO BE PROTECTED AGAINST WATER IN ACCORDANCE WITH NCC 3.8.1.2.



### PROPOSED B/V MULTI-UNITS FOR: Mr & Mrs Freyler 39-41 Nuwarra Circuit Forster

DRAWING **UNIT 2 FLOOR PLAN** 

JOB No. 3 of 7 2023-059

ISSUE

**OCT 2024** 

DRAWN BY:

SCALE


1:100 @ A3

**NEIL RYAN** 44 WOOLA ROAD TAREE Mob. 0417682880

ABN 43 831 206 704


CHECKED

A-8

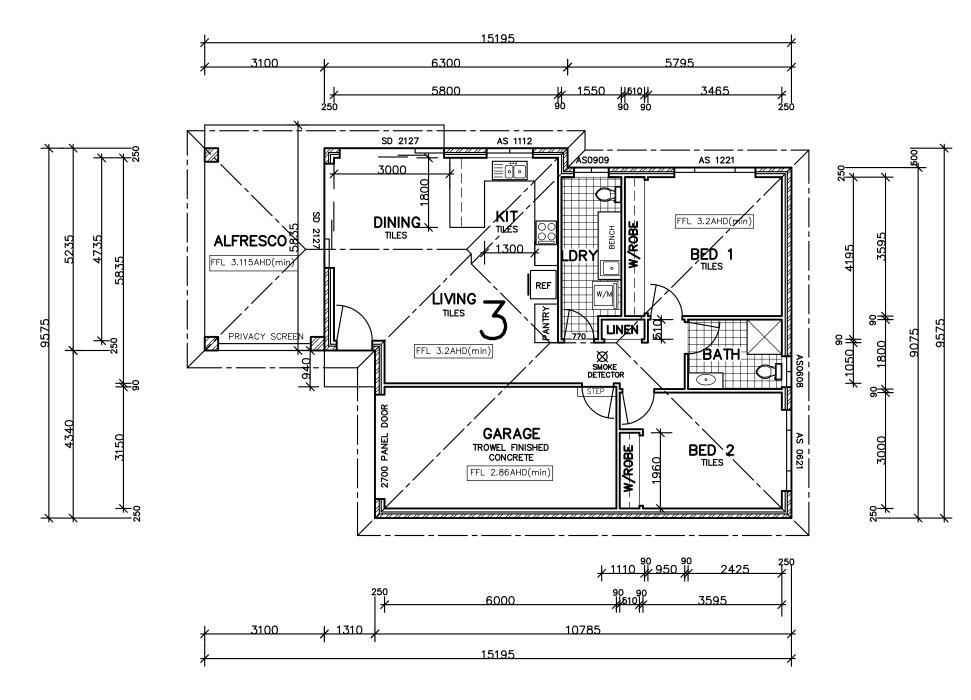

## FLOOR PLAN

SCALE 1:100 @ A3

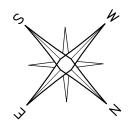



LIVING AREA = 84.1 GARAGE AREA = 23.2ALFRESCO = 16.2PATIO = 1.2

TOTAL AREA = 124.7 m2



\*NOTES\*
I NO CUT OR FILL REQUIRED NO TREES TO BE REMOVED

#### EXTERNAL COLOURS & MATERIAL FINISHES \* ROOF-COLORBOND- GREY \* GUTTER-COLORBOND- MONUMENT \* FASCIA-COLORBOND- GREY MEDIUM FACE BRICK \* BRICKS-ALUMINIUM - GREY \* WINDOWS-\* FRONT DOOR-TIMBER- CLEAR STAINED \* GARAGE DOOR-COLORBOND- GREY

ANY HEATING APPLIANCE & ASSOCIATED COMPONENT MUST BE INSTALLED BY A LICENSED PERSON & COMPLY TO BCA PART 3.10.7.
ALL CONSTRUCTION METHODS & MATERIALS MUST COMPLY TO ANY & ALL BASIX, NATHERS OR ALTERNATIVE THERMAL/ENERGY ASSESSMENTS & IT IS THE BUILDERS RESPONSIBILITY TO ENSURE ALL TRADES RECEIVE COPIES OF SUCH ASSESSMENTS. ALL EARTHWORKS ARE TO BE UNDERTAKEN STRICTLY TO COMPLY TO NCC PART 3.1. ALL STORM WATER & SURFACE DRAINAGE IS TO BE UNDERTAKEN STRICTLY TO COMPLY TO NCC 3.1. A TERMITE BARRIER MUST BE INSTALLED STRICTLY TO COMPLY TO NCC 3.1.
ALL CONCRETE FOOTINGS & SLABS
ARE TO BE CONSTRUCTED STRICTLY TO BCA 3.2. & ENGINEERS SPECIFICATIONS. ALL MASONRY & ASSOCIATED COMPONENTS IS TO BE CONSTRUCTED STRICTLY TO COMPLY TO NCC 3.3. SUB-FLOOR VENTILATION WHERE REQUIRED MUST COMPLY TO NCC ALL TIMBER FRAMING , WIND BRACING & ASSOCIATED COMPONENTS MUST COMPLY TO AS1684-N1/N2-2010 OR ENGINEERS DESIGN. ROOF CLADDING & ASSOCIATED COMPONENTS MUST BE INSTALLED STRICTLY AS TO COMPLY TO NCC 3.5.1. OR 3.5.2. GUTTERS, DOWN PIPES &
ASSOCIATED COMPONENTS MUST BE
INSTALLED STRICTLY AS TO COMPLY TO NCC 3.5.3.
ALL WALL CLADDING & ASSOCIATED COMPONENTS MUST COMPLY TO NCC 3.5.4 OR 3.5.5. ALL GLAZING IS TO COMPLY TO NCC 3.6. & ANY REQUIREMENTS UNDER BASIX, NATHERS OR ALTERNATIVE THERMAL/ENERGY ASSESSMENTS. DIRECT WIRED SMOKE DETECTORS
MUST COMPLY WITH AS3786 & BE INSTALLED AS TO COMPLY TO NCC ALL REQUIRED AREAS ARE TO BE

PROTECTED AGAINST WATER IN ACCORDANCE WITH NCC 3.8.1.2.

ISSUE

ALL CARE IS TAKEN WITH

OVER SCALE.

THE GROUND

DIMENSIONS BUT NO RESPONSIBILITY ACCEPTED FOR DISCREPANCIES. MEASUREMENTS TAKE PRECEDENCE

IT IS THE TENDER'S RESPONSIBILITY TO CHECK ALL ON SITE HEIGHTS, LEVELS & MEASUREMENTS. EVERY PART OF THE BUILDING &

ASSOCIATE COMPONENTS MUST BE CONSTRUCTED IN AN APPROPRIATE

THE BUILDING & ANY ASSOCIATED SITE WORK IS TO BE CONSTRUCTED IN A WAY THAT PROTECTS SURROUNDING OCCUPANTS &

PROPERTY FROM ADVERSE EFFECTS

OF REDIRECTED SURFACE WATER. THE BUILDING IS TO BE

CONSTRUCTED TO PROVIDE RESISTANCE TO MOISTURE FROM

OUTSIDE & MOISTURE RISING FROM

MANNER TO ACHIEVE THE REQUIREMENTS OF THE HOUSING PROVISIONS USING MATERIALS THAT ARE FIT FOR THE PURPOSE FOR WHICH THEY ARE INTENDED.



### PROPOSED B/V MULTI-UNITS FOR: Mr & Mrs Freyler 39-41 Nuwarra Circuit Forster

DRAWING **UNIT 3 FLOOR PLAN** 

JOB No. SHEET No. 4 of 7 2023-059

**OCT 2024** 

**NEIL RYAN** 


SCALE

1:100 @ A3

Mob. 0417682880 Email: admin@neilryan.com.au ABN 43 831 206 704

A-8 CHECKED

DRAWN BY: 44 WOOLA ROAD TAREE

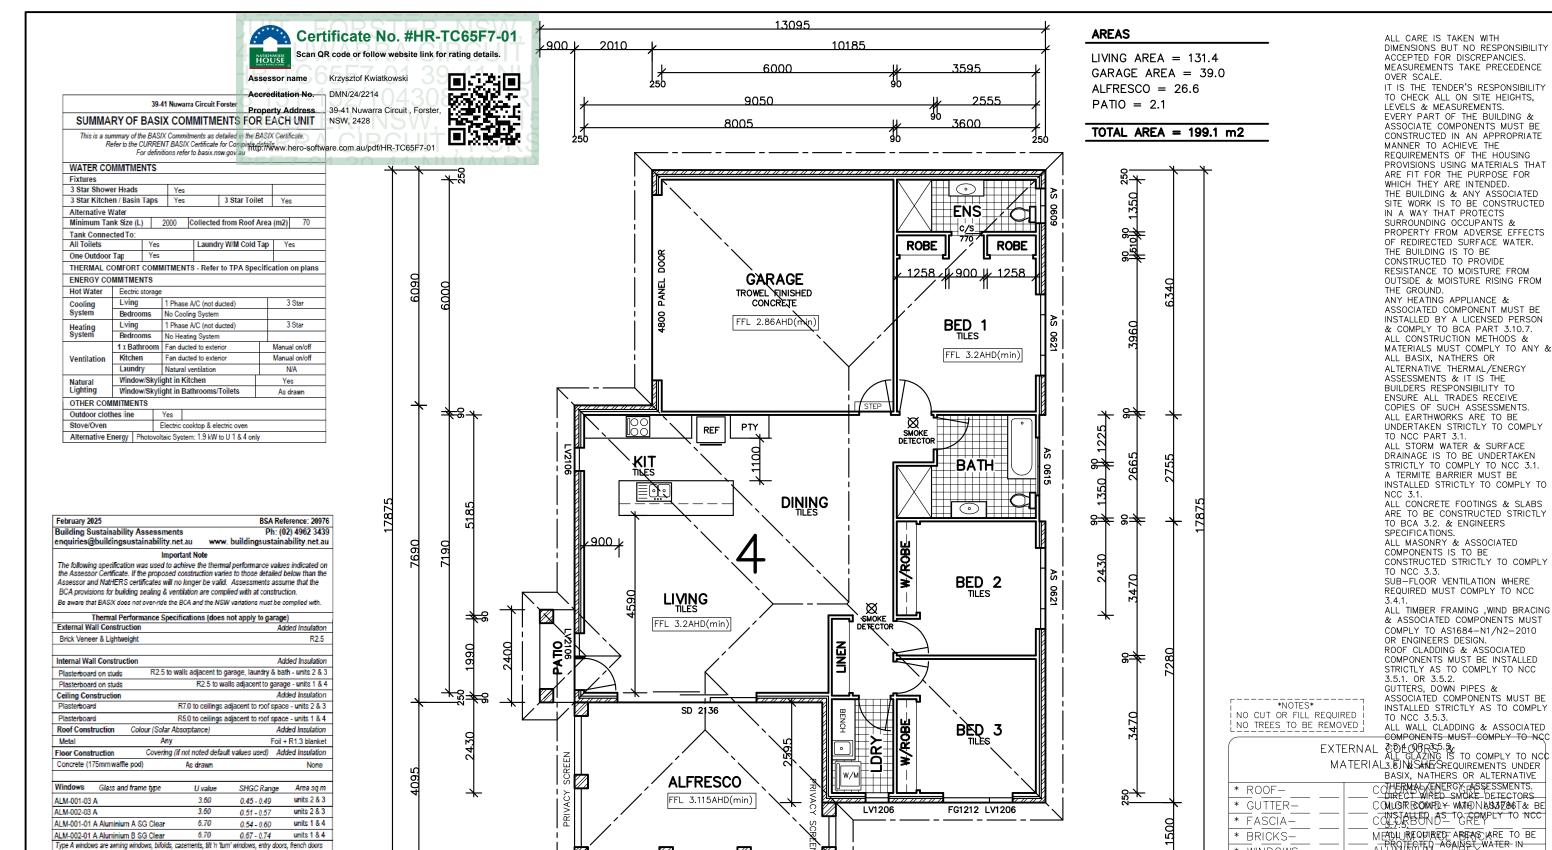

PRIVACY SCREEN

6325

900

90 90 14501/1050 1

13095

5780

Type B windows are double hung windows, sliding windows & doors, fixed windows, stacker doors, louvres

U and SHGC values are according to AFRC. Alternate products may be used if the U value is lower & the SHGC is within the range specified

(eaves, verandahs, awnings etc)

(downlights, exhaust fans, flues etc)

Skylights Glass and frame type U SHGC Area sq m

Downlights are modelled as IC rated with insulation fitted over the fixtures

Ceiling Fans used in the Modelling and to be installed in the following areas: 1x 1200mm to each bedroom; 2x 1200mm to living areas - units 2 & 3 only.

n/a

Shade elements

Ceiling Penetrations

All shade elements modelled as draw

All exhaust fans are modelled as sealed

PROTECTED AGAINST WATER IN ALACORDANCE WITH NCC 3.8.1.2. WINDOWS-FRONT DOOR-TIMBER- CLEAR STAINED \* GARAGE DOOR-COLORBOND- GREY PROPOSED B/V MULTI-UNITS FOR: Mr & Mrs Freyler 39-41 Nuwarra Circuit Forster DRAWING 5 of 7 **UNIT 4 FLOOR PLAN** 2023-059 SCALE ISSUI OCT 2024 A-8 1:100 @ A3

DRAWN BY:

NEIL RYAN 44 WOOLA ROAD TAREE Mob. 0417682880

ABN 43 831 206 704

CHECKED





## SOUTH-WEST ELEVATION

SCALE 1:100 @ A3





RYAN	PR
NEIL	E
	Dz
	DF

PROPOSED B/V MULTI-UNITS FOR: Mr & Mrs Freyler 39-41 Nuwarra Circuit Forster		
DRAWING ELEVATIONS	<sup>ЈОВ No.</sup> 2023-059	$\overset{ ext{SHEET No.}}{6}$ of $7$
DATE OCT 2024	SCALE 1:100 @ A3	ISSUE A-8

CHECKED

RAWN BY: NEIL RYAN
44 WOOLA ROAD TAREE
Mob. 0417682880

Mob. 0417682880
Email: admin@neilryan.com.au
ABN 43 831 206 704

